EXISTING GYMNASIUM 1300 N.I.C.

Interior Renovations

Student Recreation Center Administration Office Reception Desk

Montclair State University

1 Normal Avenue, Montclair, New Jersey

Project Team

Montclair State University

1 Normal Avenue Montclair, New Jersey

Principal Architect

DIGroupArchitecture

15 BETHANY STREET | NEW BRUNSWICK, NEW JERSEY 08901

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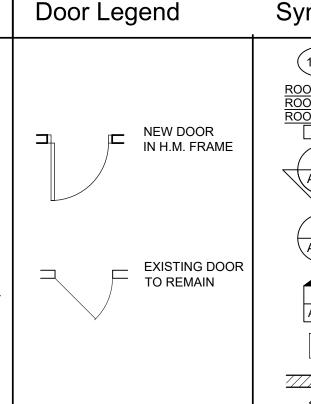
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Floor construction Including supporting beams and joists	2	2	1	0	1	0	НТ	1	0
Roof construction Including supporting beams and joists	1 ¹ / ₂ ^c	1 ^{c, d}	1 ^{c, d}	0 ^{c, d}	1 ^{c, d}	0 ^{c, d}	НТ	1 ^{c, d}	0


Code Analysis


UNIFORM CONSTRUCTION CODE (N.J.A.C. 5:23 - SUBCHAPTERS 1-12)					
2021 INTERNATIONAL BUILDING CODE - N.	J EDITION				
2021 NATIONAL STANDARD PLUMBING CODE (N.J.A.C. 5:23-3.15) 2021 INTERNATIONAL MECHANICAL CODE (N.J.A.C. 5:23-3.20) 2021 INTERNATIONAL FUEL GAS CODE (N.J.A.C. 5:23-3.22) LIFE SAFETY CODE NFPA-101 2012 EDITION 2017 ICC/ANSI A117.1-2017 BARRIER FREE SUB CODE REHABILITATION SUB CODE; (N.J.A.C. 5:23-6) STANDARDS FOR THE INSTALLATION OF AIR CONDITIONING AND VENTILATING SYSTEMS NFPA 90A-2009 INSTALLATION OF SPRINKLER SYSTEMS NFPA 13-2007 2020 NATIONAL ELECTRICAL CODE (NFPA 70) (N.J.A.C. 5:23-3.16) INTERNATIONAL ENERGY CONSERVATION CODE ASHRAE 90.1-2019					
Building Anal	ysis				
Building Anal	ysis a				
USE GROUP:	A				
USE GROUP: CONSTRUCTION CLASSIFICATION:	A IIB				
USE GROUP: CONSTRUCTION CLASSIFICATION: FULLY SPRINKLERED:	A IIB YES				
USE GROUP: CONSTRUCTION CLASSIFICATION: FULLY SPRINKLERED: AREA OF PROPOSED WORK:	A IIB YES 616 S.F				


Applicable Codes

Abbreviations							
ALUM. @ ACOUS ALT. BET. BLK. BD. BOT. BLDG. CONC. CONT. CONT. CONTR CONT. DIAM. DN. EA. EL. EXIST.	ABOVE FINISH FLOOR ALUMINUM AT ACOUSTIC ALTERNATE BETWEEN BLOCK OR BLOCKING BOARD BOTTOM BUILDING BOTTOM OF CORNER GUARD CENTER LINE CONCRETE CONCRETE MASONRY UNIT CONTINUOUS .CONTRACTOR CONTROL JOINT DCOORDINATE DETAIL DIAMETER DOWN EACH ELEVATION EDGE OF SLAB EXISTING EXPANSION JOINT	EXP. EXT. FT. FIN. FIN. FLR. F.E F.P. F.O. FL. F.O.W. FNDTN. GA. G.C. H.R. H.W. H.M. HOR. INSUL. MANUF. MANUF. MISC. N. N.I.C. N.T.S. NWR	EXPOSED EXTERIOR FEET FINISH FINISH FLOOR FIRE EXTINGUISHER FIREPROOFING FACE OF FLOOR FACE OF WALL FOUNDATION GAUGE GENERAL CONTRACTOR HAND RAIL HARDWARE HEIGHT HOLLOW METAL HORIZONTAL INSULATION MAXIMUM METAL MANUFACTURER MISCELLANEOUS NORTH NOT IN CONTRACT NOT TO SCALE NO WORK REQUIRED	O.C. PART. PNT. PTD. REV. RM. R.O. SECT. SPECS. SQ. FT. S.S. STL. SUSP. T.O. T.O.S. T.O.STL. T.O.W. TYP. U.L. U.O.N. VERT. V.I.F. W.C. WG W.P. W/ WD.	ON CENTER PARTITION PAINT PAINTED REVISION ROOM ROUGH OPENING SECTION SPECIFICATIONS SQUARE FEET STAINLESS STEEL STEEL SUSPENDED TOP OF TOP OF SLAB TOP OF STEEL TOP OF WALL TYPICAL UNDERWRITERS LABORATORY UNLESS OTHERWISE NOTED VERTICAL VERIFY IN FIELD WATER CLOSET WALL GUARD WORK POINT WITH		



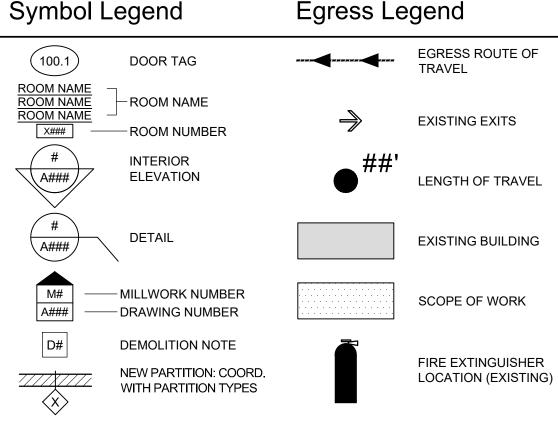

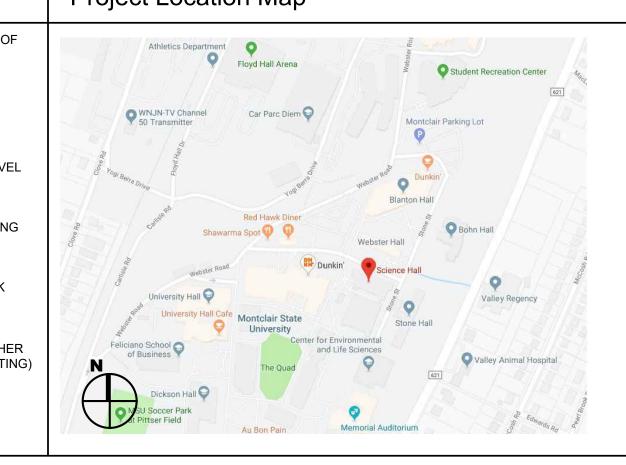

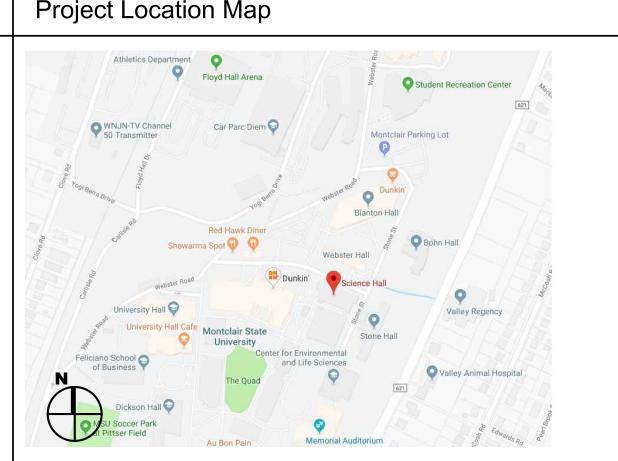

DOCUMENT REVIEW

EACH CONTRACTOR IS RESPONSIBLE FOR REVIEWING ALL ARCHITECTURAL, HVAC, FIRE PROTECTION, PLUMBING & ELECTRICAL DRAWINGS. ALL DOCUMENTS CONTAIN INFORMATION WHICH IS COMPLIMENTARY TO EACH TRADE AND MUST BE REVIEWED & UNDERSTOOD PRIOR TO CONSTRUCTION OF THIS PROJECT.

Existing First Floor Plan - Scope of Work Area

ALL WORK SHALL BE DONE IN ACCORDANCE WITH THE CURRENT BUILDING CODE OF ALL GOVERNING AUTHORITIES.

GENERAL CONTRACTOR SHALL VERIFY ALL CONDITIONS AND CHECK ALL MEASUREMENTS ON THE JOB AND SHALL BE RESPONSIBLE FOR SAME. EACH SUB-CONTRACTOR SHALL VERIFY ALL DIMENSIONS AND CONDITIONS ON THE SITE AND NOTIFY THE ARCHITECT IN WRITING OF ANY DISCREPANCIES PRIOR TO CONSTRUCTION. WORK SHALL NOT PROCEED UNTIL SUCH CLARIFICATION HAS BEEN RECEIVED. CLAIMS FOR EXTRA WORK RESULTING FROM FAILURE TO DO SO WILL NOT BE ALLOWED.

SHOULD UNFORESEEN CONDITIONS OR OTHER CAUSES NECESSITATE CONSTRUCTION DETAILS NOT IN ACCORDANCE WITH THESE DRAWINGS, THE CONTRACTOR SHALL NOTIFY THE ARCHITECT AND SUBMIT DETAILS, FOR ARCHITECT'S REVIEW SHOWING THE PROPOSED METHODS TO ACCOMPLISH THE REQUIRED RESULTS, AND AWAIT ARCHITECT'S INSTRUCTIONS.

PROTECT FROM DAMAGE ALL STRUCTURES, FINISHES, UTILITIES, EQUIPMENT, ETC. SCHEDULED TO REMAIN. MAINTAIN THE STRUCTURAL INTEGRITY OF THE BUILDING. PROVIDE TEMPORARY PROTECTIVE DUST AND WATERTIGHT ENCLOSURES WHERE AND WHEN REQUIRED AS PER THE OWNERS DIRECTIVE. EACH SUB-CONTRACTOR SHALL BE RESPONSIBLE FOR ADEQUATELY BRACING AND PROTECTING ALL WORK DURING CONSTRUCTION AGAINST DAMAGE, BREAKAGE, COLLAPSE, DISTORTIONS AND MISALIGNMENT ACCORDING TO THE APPLICABLE CODES, STANDARDS AND GOOD PRACTICE.

THE AREA IMMEDIATE TO THE WORK SITE SHALL BE KEPT CLEAN AT ALL TIMES BY EACH SUB-CONTRACTOR. REMOVE ALL DEBRIS FROM THE SITE TO A POINT OF LEGAL DISPOSAL. THE GENERAL CONTRACTOR WILL SUPPLY A CONTAINER FOR THIS PURPOSE. OWNER TO INSTRUCT OF APPROVED TEMPORARY ON-SITE LOCATION. **GYPSUM DRYWALL & FRAMING**

ALIGN PARTITION AND WALL ASSEMBLIES TO A TOLERANCE OF ONE IN 200 HORIZONTALLY AND ONE IN 500 VERTICALLY. SPACE THE STUDS AS REQUIRED FOR COMPLIANCE WITH PERTINENT REGULATIONS TO GIVE PROPER SUPPORT FOR THE COVERING MATERIAL AND AS INDICATED ON THE DRAWINGS.

COORDINATE AND PROVIDE PROPER BACKING AND OTHER SUPPORT FOR ITEMS TO BE MOUNTED ON THE FINISH COVERING. **GYPSUM DRYWALL**

SUBJECT TO COMPLIANCE WITH REQUIREMENTS PROVIDE PRODUCTS OF ONE OF THE FOLLOWING MANUFACTURERS: GYPSUM BOARDS AND RELATED PRODUCTS:

GOLD BOND BUILDING PRODUCTS DIV., NATIONAL GYPSUM CO.

UNITED STATES GYPSUM CO.

GEORGIA-PACIFIC CORP.

PROVIDE GYPSUM BOARD OF TYPES INDICATED IN MAXIMUM LENGTHS AVAILABLE TO MINIMIZE END-TO-END JOINTS.

GENERAL CONSTRUCTION NOTES

CONCEALED SPACES WITHIN WALL PARTITIONS SHALL BE FIRESTOPPED PER CODE. PROVIDE ONE LAYER OF 5/8" GYPSUM WALL BOARD ON EACH FACE OF ALL INTERIOR PARTITIONS, PROVIDE CORNER BEAD, CASING BEAD, "J" MOLD, TAPE ETC. AS REQUIRED. PROVIDE THREE COATS OF JOINT COMPOUND SANDED AND READY FOR THE SCHEDULED FINISH. APPLICATION PROCEDURES AND WORKMANSHIP FOR ALL GYPSUM WALL BOARD SHALL BE IN ACCORDANCE WITH ANSI A971. NO EXPOSED EDGE OR CORNER SHALL BE WITHOUT A PROTECTIVE BEAD.

ALL WOOD BLOCKING IN WALLS SHALL BE FIRE RETARDANT TREATED WOOD.

ALL METAL STRAPPING IN WALLS SHALL BE 18 GAGE STEEL

FLOORING

• SCREWS: SELECT MATERIAL, TYPE, SIZE, AND FINISH REQUIRED FOR EACH USE. COMPLY WITH FS FF-S-111 FOR APPLICABLE REQUIREMENTS. FOR METAL FRAMING SUPPORTS, PROVIDE SCREWS AS RECOMMENDED BY METAL FRAMING MANUFACTURER.

• NAILS: SELECT MATERIAL, TYPE, SIZE, AND FINISH REQUIRED FOR EACH USE. COMPLY WITH FS FF-N-105 FOR APPLICABLE REQUIREMENTS.

ANCHORS: SELECT MATERIAL, TYPE, SIZE, AND FINISH REQUIRED BY EACH SUBSTRATE FOR SECURE ANCHORAGE. PROVIDE NONFERROUS METAL OR HOT-DIP GALVANIZED ANCHORS AND INSERTS ON INSIDE FACE OF EXTERIOR WALLS AND ELSEWHERE AS REQUIRED FOR CORROSION RESISTANCE. PROVIDE TOOTHED STEEL OR LEAD EXPANSION BOLT DEVICES FOR DRILLED- IN-PLACE ANCHORS.

COORDINATION: FIT CARPENTRY WORK TO OTHER WORK; SCRIBE AND COPE AS REQUIRED FOR ACCURATE FIT. CORRELATE LOCATION OF FURRING, NAILERS, BLOCKING, GROUNDS AND SIMILAR SUPPORTS TO ALLOW ATTACHMENT OF OTHER WORK.

INSTALLER MUST EXAMINE THE SUBSTRATES AND SUPPORTING STRUCTURE AND THE CONDITIONS UNDER WHICH THE CARPENTRY WORKS TO BE INSTALLED AND NOTIFY THE GENERAL CONTRACTOR IN WRITING OF CONDITIONS DETRIMENTAL TO THE WORK. DO NOT PROCEED WITH THE INSTALLATION UNTIL UNSATISFACTORY CONDITIONS HAVE BEEN CORRECTED IN A MANNER ACCEPTABLE TO THE INSTALLER.

INSTALL RUBBER EDGE STRIPS AT UNPROTECTED OR EXPOSED EDGES, AND WHERE FLOORING TERMINATES. SCRIBE FLOORING TO WALLS, COLUMNS, CABINETS, FLOOR OUTLETS AND OTHER APPURTENANCES TO PRODUCE TIGHT JOINTS. FIT WALL BASE JOINTS TIGHT AND VERTICAL. MAINTAIN MINIMUM MEASUREMENT OF 18 INCHES BETWEEN JOINTS. MITER INTERNAL CORNERS. AT EXTERNAL CORNERS AND EXPOSED ENDS, USE PREMOLDED UNITS. INSTALL BASE ON SOLID BACKING, BOND TIGHT TO WALL AND FLOOR SURFACES. CLEAN FLOOR AND BASE SURFACES IN ACCORDANCE WITH MANUFACTURER'S INSTRUCTIONS. PROHIBIT TRAFFIC ON FLOOR FINISH FOR 48 HOURS AFTER INSTALLATION.

EXISTING FLOORING IS TERRAZZO, CONTRACTOR SHALL PROTECT EXISTING FLOORING TO THE GREATEST EXTENT POSSIBLE DURING CONSTRUCTION. SHOULD FLOORING BE DAMAGED DURING CONSTRUCTION, CONTRACTOR TO CARRY ALLOWANCE FOR REPAIR/REPLACEMENT OF

PAINTING

DO NOT APPLY MATERIALS WHEN SURFACE AND AMBIENT TEMPERATURES ARE OUTSIDE THE TEMPERATURE RANGES REQUIRED BY THE PAINT PRODUCT MANUFACTURER.

REMOVE ELECTRICAL PLATES, HARDWARE, LIGHT FIXTURE TRIM, ESCUTCHEONS AND FITTINGS PRIOR TO PREPARING SURFACES FOR

CORRECT DEFECTS AND CLEAN SURFACES THAT AFFECT THIS WORK. REMOVE EXISTING COATINGS THAT EXHIBIT LOOSE SURFACE DEFECTS. SEAL MARKS THAT MAY BLEED THROUGH SURFACE FINISHES.

GYPSUM BOARD SURFACES: FILL MINOR DEFECTS WITH FILLER COMPOUND. SPOT PRIME DEFECTS AFTER REPAIR.

PAINT EXPOSED CONDUIT AND ELECTRICAL EQUIPMENT OCCURRING IN FINISHED AREAS.

APPLY PAINT IN ACCORDANCE WITH THE FOLLOWING SCHEDULE:

EXTERIOR SURFACES STEEL - UNPRIMED ONE COAT OF ALKYD PRIMER TWO COATS OF ALKYD ENAMEL, SEMI-GLOSS

STEEL - SHOP PRIMED TOUCH-UP WITH ZINC RICH PRIMER TWO COATS OF ALKYD ENAMEL, SEMI-GLOSS

STEEL - GALVANIZED ONE COAT OF GALVANIZE PRIMER TWO COATS OF ALKYD ENAMEL, SEMI-GLOSS

ONE COAT OF PRIMER TWO FINISH COATS

INTERIOR SURFACES CONCRETE MASONRY ONE COAT OF LATEX BLOCK FILLER TWO COATS OF ACRYLIC LATEX, SATIN

STEEL - UNPRIMED ONE COAT OF ALKYDPRIMER

STEEL - PRIMED TOUCH-UP WITH ORIGINAL PRIMER TWO COATS OF LATEX ENAMEL, SATIN

TWO COATS OF LATEX ENAMEL, SATIN

PLASTER, GYPSUM BOARD: ONE COAT OF LATEX PRIMER SEALER TWO COATS OF LATEX EGGSHELL

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OO NOT SCALE. DRAWING MAY BE PRINTED AT REDUCED

SCALE. CONSULT WITH ARCHITECT FOR DIMENSIONS.

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Admin Reception Desk Renovation at Student Recreation Center MSU Project Number: PR20C014

Drawing Information:

Project No: 23.027 Drawn By: SBT Checked By: CHK

Code Date, Notes and Legends

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DEMOLITION NOTES

- A. THE FOLLOWING ARE MEANT TO GENERALLY DESCRIBE THE SCOPE OF THE SELECTIVE DEMOLITION ITEMS FOR THIS PROJECT. PRIOR TO BIDDING THIS PROJECT, IT SHALL BE THE CONTRACTORS RESPONSIBILITY TO VERIFY QUANTITIES, MATERIALS, REQUIRED WORKING HEIGHTS (FOR REMOVALS SUCH AS CEILINGS), EXISTING FASTENING METHODS (FOR ACTUAL REMOVAL EFFORT REQUIRED), AND OTHER EXISTING CONSTRUCTION DETAILS RELEVANT TO THE EFFORT REQUIRED FOR THE DEMOLITION DESCRIBED HEREIN. THE CONTRACTOR IS RESPONSIBLE TO CAREFULLY REMOVE AND / OR RELOCATE ALL MATERIAL AND EQUIPMENT REQUIRED TO FACILITATE THE ALTERATIONS AND IMPROVEMENTS DESCRIBED IN THESE DOCUMENTS, WHETHER THE DEMOLITION ITEM OF WORK IS DESCRIBED IN THESE DOCUMENTS, OR NOT.
- B. DEMOLITION WORK, AS SPECIFIED HEREIN, IS TO BE PERFORMED COMPLETELY BY THE CONTRACTOR. "COMPLETELY" SHALL MEAN THE SPECIFIC OBJECT NAMED AND ANY ACCESSORY OR AUXILIARY ITEMS WHICH WOULD REASONABLY BE CONSIDERED AS PART OF THE ITEM NAMED SUCH AS FOUNDATIONS, FOOTINGS, RAILINGS, ELBOWS, BOLTS, NUTS, ETC. "COMPLETELY" SHALL ALSO MEAN ABOVE GRADE AND BELOW GRADE FOR ALL DEMOLITION REMOVAL AND DISPOSAL.
- C. THE DEMOLITION CONTRACTOR SHALL TAKE ALL NECESSARY PRECAUTIONS TO PROTECT EXISTING UTILITIES AND MAINTAIN UNINTERRUPTED SERVICE. ANY DAMAGES RESULTING FROM THE CONTRACTORS FAILURE TO DO SO SHALL BE IMMEDIATELY AND COMPLETELY REPAIRED AT THE CONTRACTORS EXPENSE. THE CONTRACTOR SHALL VERIFY THE LOCATION AND ELEVATION OF ALL EXISTING UTILITIES BY TEST PIT OR OTHER MEANS PRIOR TO DEMOLITION IN THE VICINITY OF THE
- D. THE EXTENT OF ITEMS TO BE REMOVED ON THE DEMOLITION PLAN ARE SHOWN BY BROKEN LINES. IT SHALL BE THE RESPONSIBILITY OF THE GENERAL CONTRACTOR TO NOTIFY THE ARCHITECT OF ANY CONFLICTS PRIOR TO THE START OF
- E. PRIOR TO THE START OF WORK, IN EACH ROOM, THE CONTRACTOR SHALL VERIFY THAT ALL LOOSE FURNITURE, SHELVING, PICTURES, PROJECTION SCREENS, ARTWORK, VENDING MACHINES, TABLES, PLAQUES, DIRECTORIES, ROOM SIGNAGE, OFFICE EQUIPMENT, COMPUTERS, ETC. HAVE BEEN REMOVED FROM EACH ROOM. IF THIS HAS NOT BEEN DONE, NOTIFY THE OWNER IMMEDIATELY. DO NOT PROCEED WITH WORK UNTIL ROOM IS CLEAR AND EMPTY OF ANY/ALL ITEMS DESCRIBED
- F. DIMENSIONS GIVEN AND INFORMATION SHOWN REFLECT EXISTING CONDITIONS TAKEN FROM FORMER ARCHITECTURAL, STRUCTURAL, AND MECHANICAL DOCUMENTS. ALL EXISTING CONDITIONS ARE TO BE FIELD VERIFIED PRIOR TO REMOVAL AND DEMOLITION WORK, FABRICATION AND INSTALLATION OF NEW PARTITIONS AND MECHANICAL/ELECTRICAL COMPONENTS.
- G. THE DEMOLITION CONTRACTOR SHALL BE RESPONSIBLE FOR THE OFFSITE DISPOSAL OF ANY AND ALL EXCESS MATERIAL AND OTHER UNSUITABLE MATERIAL UNABLE TO BE USED ON SITE.
- H. EXISTING FINISHES THAT HAVE BEEN PREVIOUSLY DAMAGED, OR ARE DAMAGED DURING CONSTRUCTION AND CONSTRUCTION WORK SHALL BE REPAIRED TO MATCH ADJACENT EXISTING CONSTRUCTION. ALL EXISTING FINISHES ARE TO BE ALTERED. REMOVED. AND REPAIRED AS REQUIRED TO PROVIDE NEW FINISHES AS SCHEDULED.
- ALL EXISTING WALLS, CEILINGS, TRIM, ETC. TO RECEIVE NEW PAINT FINISH SHALL BE REPAIRED, SCRAPED, SANDED, AND CLEANED AS REQUIRED PRIOR TO APPLICATION OF NEW PAINT.
- J. WORK SHALL BE PERFORMED IN STRICT ACCORDANCE WITH NATIONAL, STATE, LOCAL, AND ALL OTHER APPLICABLE CODES AND REQUIREMENTS AS DETERMINED BY AUTHORITIES HAVING JURISDICTION.
- K. ROOM NAMES AND NUMBERS REFLECT EXISTING CONDITIONS TAKEN FROM FORMER ARCHITECTURAL DOCUMENTS AND MAY DIFFER FROM WHAT IS IN THE FIELD.
- . GENERAL CONTRACTOR SHALL COORDINATE REMOVAL OF ANY EXISTING MECHANICAL, PLUMBING, AND ELECTRICAL OUTLETS, DEVICES OR SWITCHING LOCATED ON WALLS SCHEDULED TO REMAIN AND SHALL BE REMOVE ALL CIRCUITING / WIRING BACK TO THE ELECTRIC PANEL(S) PROVIDING POWER. GENERAL CONTRACTOR TO COORDINATE THE REMOVAL OF ALL PLUMBING, MECHANICAL, AND ELECTRICAL ITEMS WITH RESPECTIVE CONTRACTORS. GENERAL CONTRACTOR SHALL BE RESPONSIBLE FOR THE PATCHING AND REPAIR OF EXISTING WALL WHERE DEVICES ARE REMOVED AND SHALL PREPARE SURFACES AS REQUIRED TO RECEIVE NEW SCHEDULED FINISHES.

DEMOLITION LEGEND

- REMOVE EXISTING MILLWORK RECEPTION DESK AND KNEE WALL PARTITION. TAKE SPECIAL CARE TO PROTECT WALLS AROUND RECEPTION DESK. PATCH, CLEAN AND REPAIR ADJACENT SURFACES TO REMAIN. PATCH AND REPAIR EXISTING WALLS AND FLOORS ADJACENT AS NECESSARY TO RECEIVE NEW FINISHES.
- D2 REMOVE ELECTRICAL/LOW VOLTAGE COMPONENTS, DOOR RELEASE CONTROL PANEL, TELEPHONE SYSTEM, DATA AND RECEPTACLES. SALVAGE AND RETURN COMPONENTS TO UNIVERSITY OFFICE OF INFORMATION TECHNOLOGY AND SECURITY RESPECTIVELY.
- D3 REMOVE EXISTING FLOORING FINISH (CARPET), BASE AND RELATED TRIM PIECES. PATCH, CLEAN AND PREPARE EXISTING FLOOR SLAB AS REQUIRED TO RECEIVE NEW SCHEDULED FINISH.
- D4 DEMOLISH EXISTING PLEXIGLASS WALL PROTECTION IN HALLWAY AND PREPARE WALLS TO RECEIVE NEW WALL PANELS. PREPARE WALLS CONSISTENT WITH LEVEL OF FINISH RECOMMENDED BY WALL PROTECTION
- GENERAL CONTRACTOR SHALL PROVIDE SIGNAGE STATING THAT WORK IS BEING DONE IN BUILDING AND SHALL BE POSTED AT FRONT DOOR AND NEAR WORK SITE(S) PRIOR TO BEGINNING OF CONSTRUCTION. WORK AREA IS TO BE SECURED BY CAUTION TAPE, BARRICADE(S), CONES, ÈTC. TO PREVENT ACCESS TO WORK ZONES.

RENOVATION SOLID WASTE AND RECYCLING REQUIREMENTS: A. RECYCLING REQUIREMENTS: THE ITEMS BELOW ARE REQUIRE TO BE RECYCLED: 1. FLUORESCENT LIGHT TUBES - PROPERLY BOXED & LABELED.

- ELECTRONIC BALLASTS IN 55 GALLON DRUMS LABELED. 3. CEILING TILES THAT DO NOT CONTAIN ASBESTOS, ARE NOT COATED WITH FIBERGLASS, AND WITHOUT ATTACHED
- INSULATION STACKED ON PALLETS SHRINK WRAPPED TO AVOID CONTAMINATION AND WATER DAMAGE. 4. ALUMINUM SIDING STACKED AND BOUND.
- 5. CARDBOARD PACKING BOXES, BROKEN DOWN AND IN AN APPROPRIATE COVERED DUMPSTER. 6. STEEL IN LABELED COVERED DUMPSTER.
- WOOD IN LABELED COVERED DUMPSTER. CARPET (ALL TYPES) AND PADDING IN LABELED COVERED DUMPSTER FROM RECYCLER. 9. CONCRETE/BLOCK IN LABELED COVERED DUMPSTERS.
- B. TRANSPORT: ALL ITEMS ARE TO BE PROPERLY TRANSPORTED TO APPROPRIATE RECYCLING CENTERS OR RETRIEVED BY RECYCLING COMPANIES.
- C. <u>SOLID WASTE</u>: ALL OTHER WASTE MUST BE CAPTURED IN COVERED (DOG HOUSE STYLE) WASTE DUMPSTERS MUST BE REMOVED FROM SITE WHEN FULL, OVERLOADED DUMPSTERS WILL NOT BE TOLERATED.

FINISH NOTES & SPECIFICATIONS

- 1. ALL APPLIED MATERIALS SHALL BE CLASSIFIED CLASS "A" FLAME SPREAD RATING: FLAME SPREAD = 0-25; SMOKE DEVELOPED = 0-450
- 2. DECORATIVE MATERIALS AND TRIM SHALL BE RESTRICTED BY PERFORMANCE CRITERIA OF NFPA 101
- 3. ALL FLOOR TILE MATERIAL SHALL BE PROVIDED WITH A MIN 0.60 COFFEICIENT OF FRICTION FACTOR

	3. ALL FLOOR T	ILE MATERIAL SHALL BE PROVIDED WITH A MIN. 0.6	0 COEFFICIENT OF FRICTI	ON FACTOR.		
	WALLCOVERING (WO	C-1)	PLASTIC LAMINATE (PL-1)			
	MANUFACTURER:		MANUFACTURER:			
	PRODUCT:	DEW15303 MAGNETIC RECEPTIVE	COLOR/STYLE:	PORT D14-60		
		DRY ERASE WALLCOVERING				
	WIDTH/THICKNESS/V	VEIGHT: 48" / 30 MILS / 54 OZ/SQ.YD.	PLASTIC LAMINATE	(PL-2)		
			MANUFACTURER:	WILSONART		
	WALL PROTECTION	(WP-1)	COLOR/STYLE:	LOFT OAK 7968K-12		
	MANUFACTURER:	MDC				
	COLLECTION:	DURATEC	PLASTIC LAMINATE	(PL-3)		
	STYLE:	PALOMAR	MANUFACTURER:	WILSONART		
	COLOR:	HAZELNUT MDV1041	COLOR/STYLE:	MAGNOLIA 5012K-19		
	WIDTH/THICKNESS/V	VEIGHT: 50-52" / .035" / 38 OZ/LYD				
	INSTALLATION:		PLASTIC LAMINATE (PL-4)			
	ON ALL WALLS	WITHIN EXISTING OFFICE SUITE 1100 U.O.N.,	MANUFACTURER:	WILSONART		
	FROM TOP OF	4" VINYL BASE TO 42" A.F.F.	COLOR/STYLE:	GREY 1500-60		
LUXURY VINYL TILE (LVT-1)			SOLID SURFACE (SS-1)			
	MANUFACTURER:	SHAW CONTRACT	MANUFACTURER:	DUPONT CORIAN		
	COLLECTION:	DIALOGUE	COLOR/STYLE:	CIRRUS WHITE		
	STYLE:	4143V	SIZE:	12MM GAUGE		
	COLOR:	DESCRIBE 43530				

COLOR/STYLE: DARK BROWN 44 MANUFACTURER: DECORATIVE FILM - SOLYX PRODUCT: SXWF-SSO SATIN SILVER OPAQUE SIZE: 60" ROLL WIDTH

SIZE:

INSTALL:

INSTALL:

MANUFACTURER:

GLASS FILM

FINISH ABBREVIATIONS

6" X 48"

ASHLAR PATTERN

SEE ELEVATION 3/A-100

GF

JOHNSONITE

LIGHTING SCOPE

DUPONT CORIAN NATURAL GRAY 12MM GAUGE

MATERIAL	ABBREVIATION
FLOORING:	
LUXURY VINYL TILE	LVT
BASE:	
VINYL BASE	VB
WALL:	
PAINT	PNT
WALL COVERING	WC
WALL PROTECTION	WP
MILLWORK:	
PLASTIC LAMINATE	PL
SOLID SURFACE	SS
MISCELLANEOUS:	<u>'</u>

ADDITION OF (2) NEW LED PENDANTS ABOVE NEW RECEPTION DESK, WHERE NOTED IN PLAN, AND ONE NEW SWITCH WITH DIMMER. FIXTURE LOCATIONS TO BE VERIFIED IN FIELD AND COORDINATE WITH EXISTING TO REMAIN CEILING AND LIGHTING. NEW SWITCH TO BE LOCATED NEXT TO EXISTING SWITCH WITHIN SUITE 1100. PENDANTS ARE TO BE "ELEMENTUM MINI LED PENDANT BY LUMENS" OR APPROVED EQUAL.

- NEW SWITCH/CONTROLS FOR **LOBBY** NEW LED PENDANTS, LOCATE NEXT TO EXISTING SWITCH. 11C2 11C2 N.I.C. N.I.C. - RELOCATE POWER FROM EXISTING RECEPTACLE INTO NEW CASEWORK DESK. D1 D2 RELOCATE EXISTING RECEPTACLE 44" AFF COORD HEIGHT W/ **EXISTING NEW COUNTER** OFFICE SUITE OFFICE SUITE ELEMENTUM MINI LED/ PENDANT BY LUMENS[™] OR APPROVED EQUAL — EXISTING ELECTRICAL PANEL RP-1C




Partial 1st Floor Demolition Plan SCALE: 3/16" = 1'-0"



Partial 1st Floor Plan - New Work

SCALE: 3/16" = 1'-0"

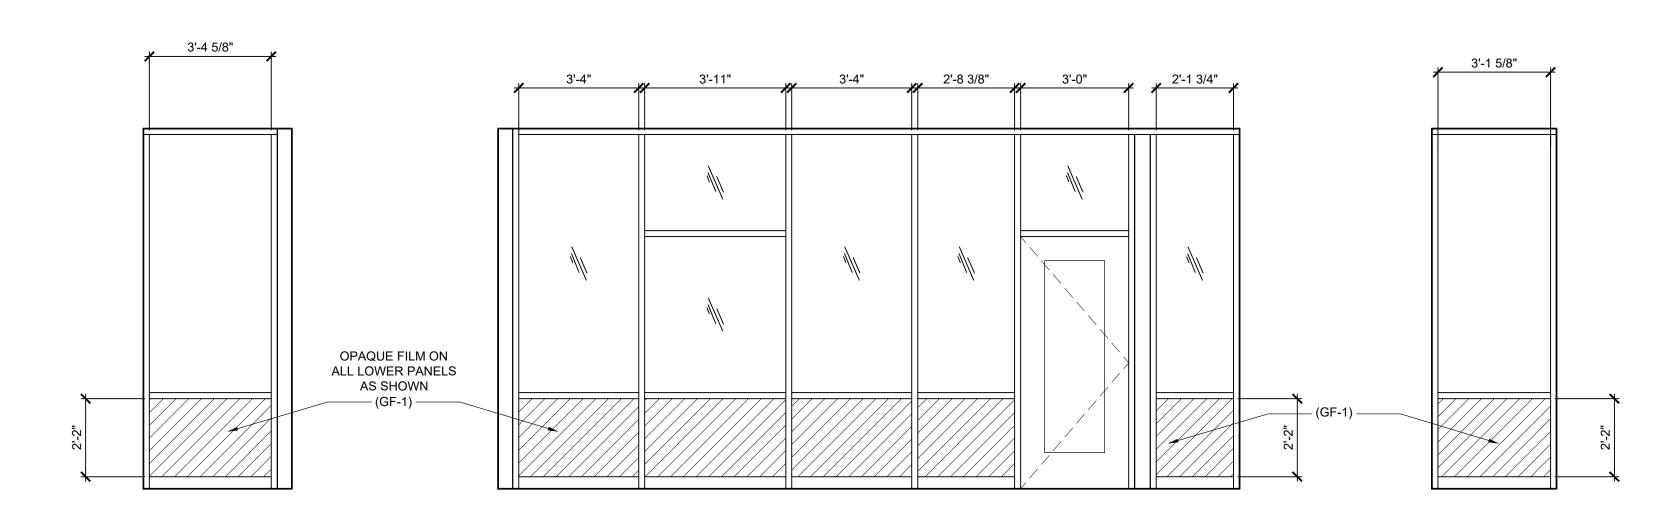

Hollow Metal Elevation

SCALE: 3/8" = 1'-0"

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DO NOT SCALE. DRAWING MAY BE PRINTED AT REDUCED SCALE. CONSULT WITH ARCHITECT FOR DIMENSIONS.

Montclair State University 1 Normal Avenue

Project:

Montclair, NJ 07043

Admin Reception Desk Renovation at Student Recreation Center MSU Project Number: PR20C014

Drawing Information: Project No: 23.027 Date: 07/18/2023 Drawn By: SBT


Checked By: CHK

Sheet Name:

Demolition Plan, Floor Plan and **Elevations**

Sheet No:

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MILLWORK CONSTRUCTION NOTES

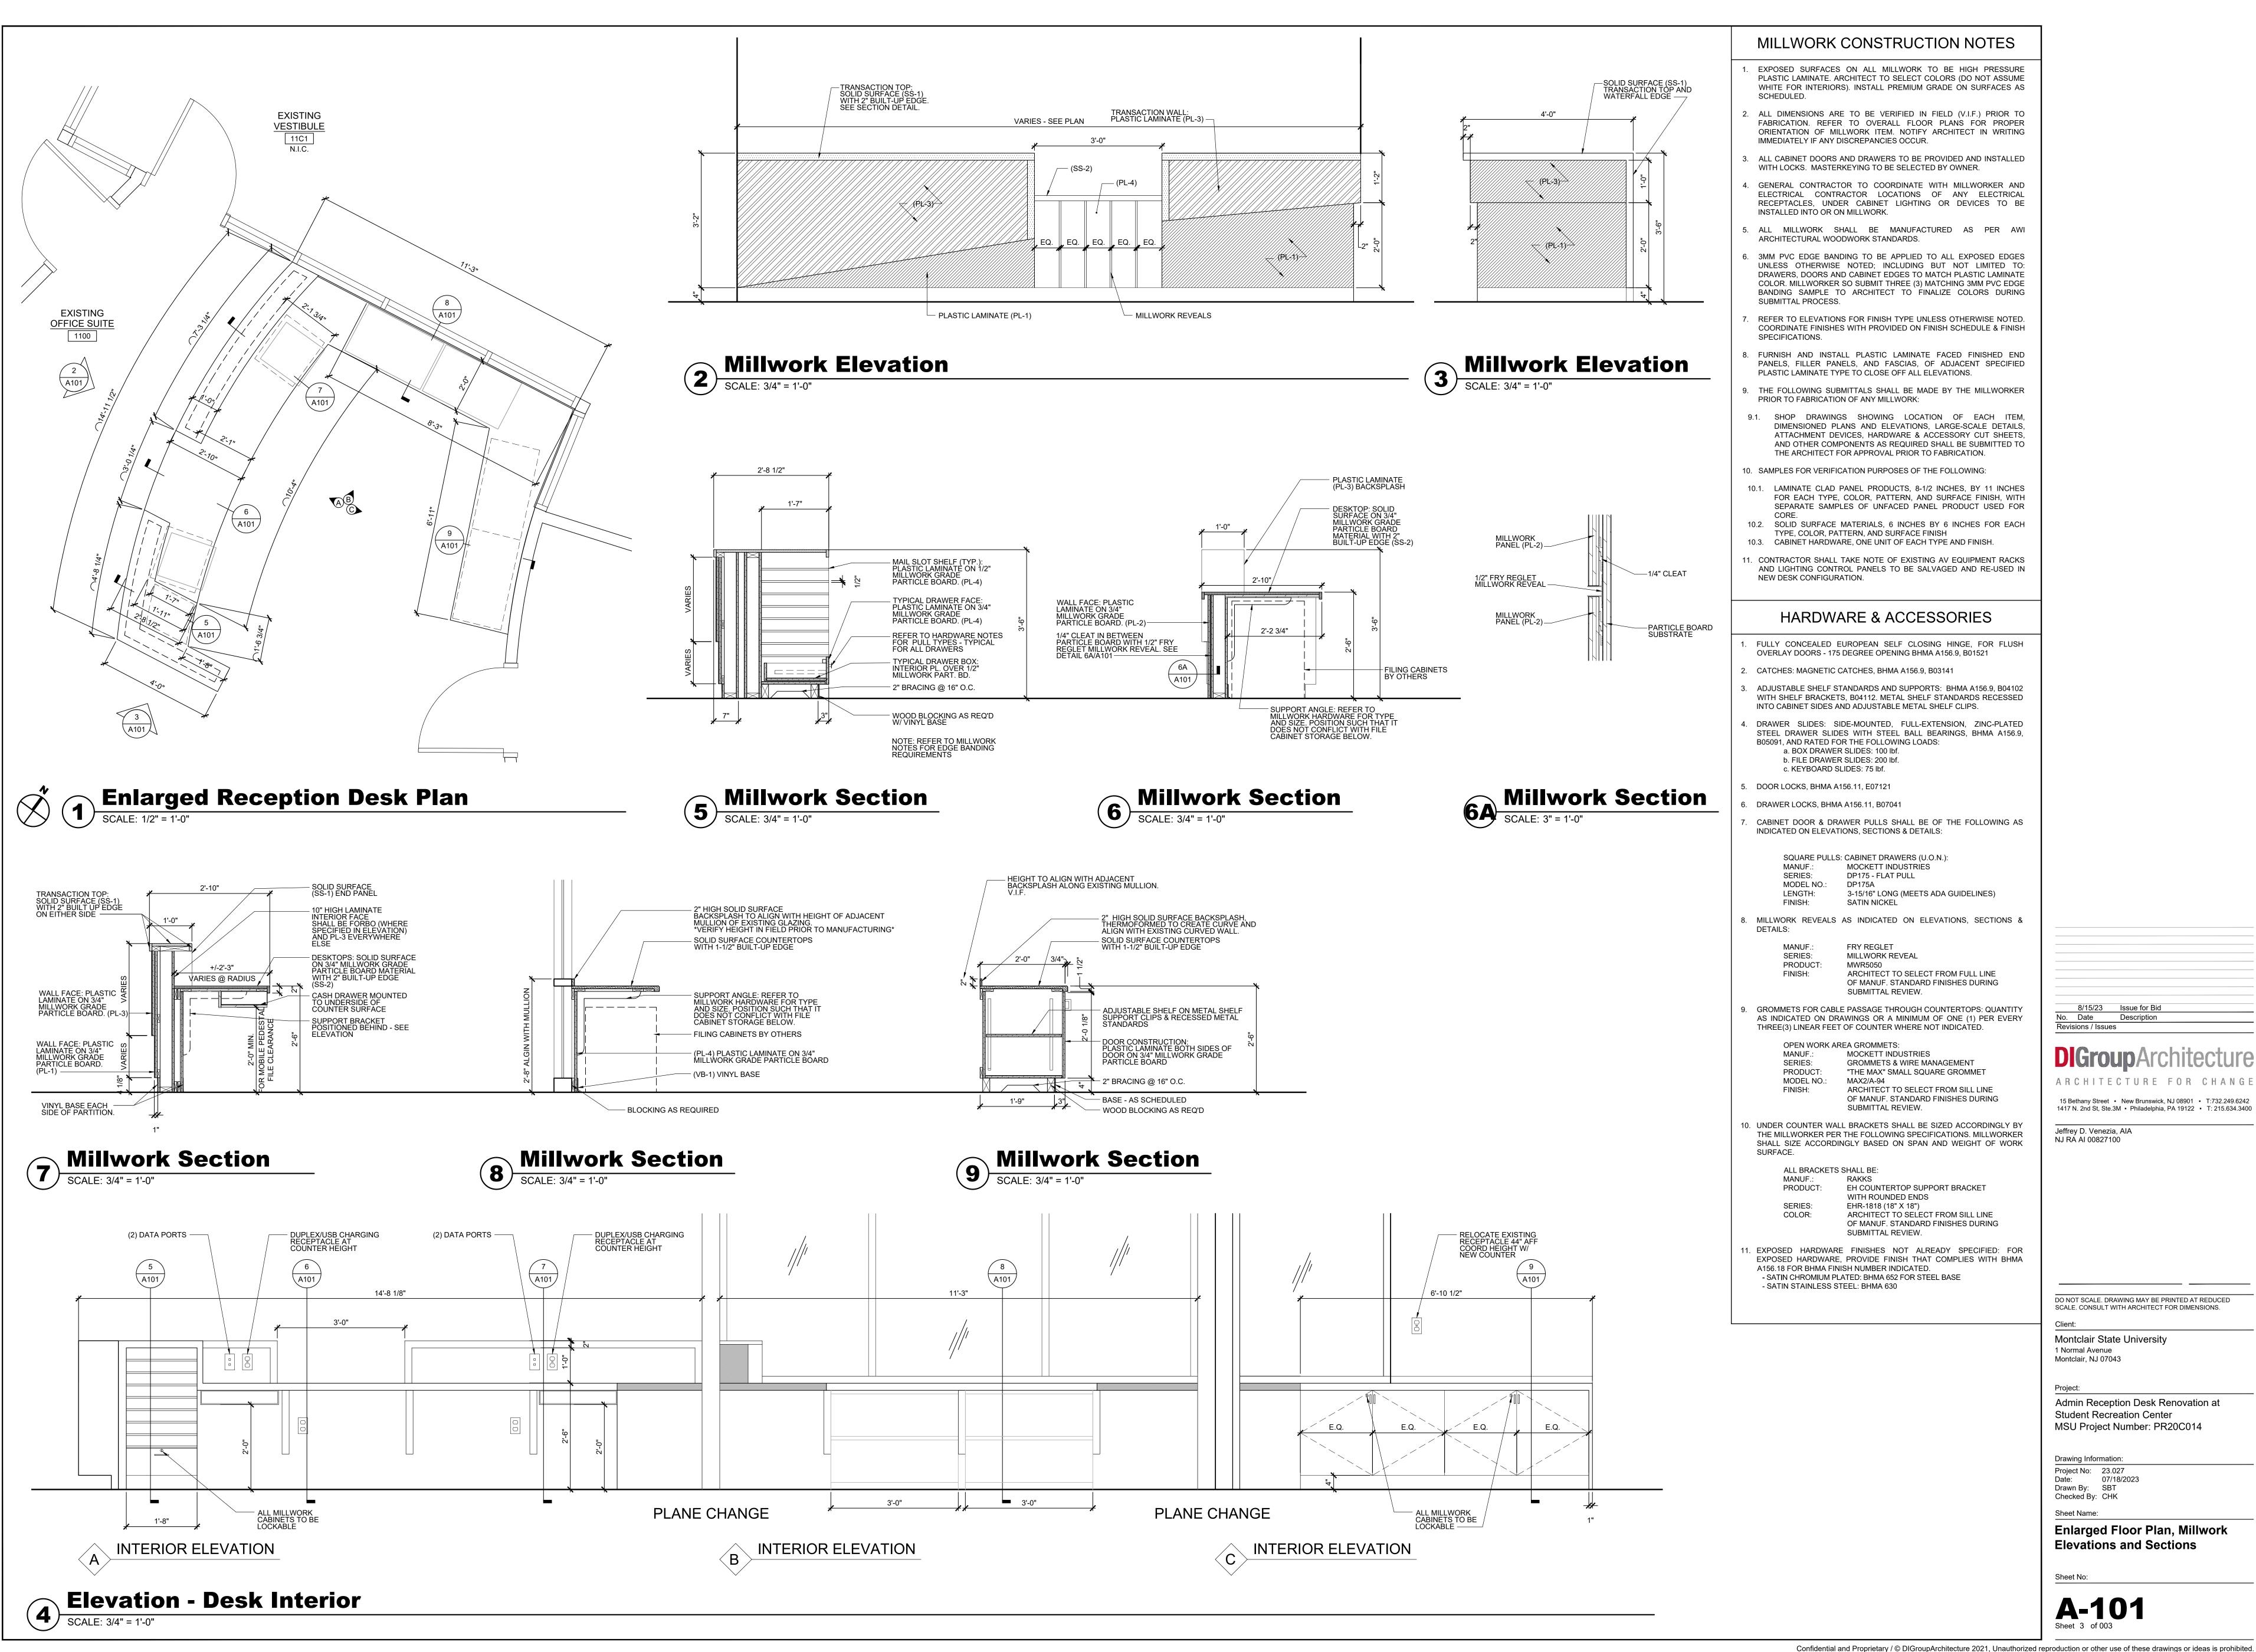- EXPOSED SURFACES ON ALL MILLWORK TO BE HIGH PRESSURE PLASTIC LAMINATE. ARCHITECT TO SELECT COLORS (DO NOT ASSUME WHITE FOR INTERIORS). INSTALL PREMIUM GRADE ON SURFACES AS
- ALL DIMENSIONS ARE TO BE VERIFIED IN FIELD (V.I.F.) PRIOR TO FABRICATION. REFER TO OVERALL FLOOR PLANS FOR PROPER ORIENTATION OF MILLWORK ITEM. NOTIFY ARCHITECT IN WRITING
- ALL CABINET DOORS AND DRAWERS TO BE PROVIDED AND INSTALLED WITH LOCKS. MASTERKEYING TO BE SELECTED BY OWNER.
- 4. GENERAL CONTRACTOR TO COORDINATE WITH MILLWORKER AND ELECTRICAL CONTRACTOR LOCATIONS OF ANY ELECTRICAL RECEPTACLES, UNDER CABINET LIGHTING OR DEVICES TO BE
- 5. ALL MILLWORK SHALL BE MANUFACTURED AS PER AWI
- 3MM PVC EDGE BANDING TO BE APPLIED TO ALL EXPOSED EDGES UNLESS OTHERWISE NOTED; INCLUDING BUT NOT LIMITED TO: DRAWERS, DOORS AND CABINET EDGES TO MATCH PLASTIC LAMINATE COLOR. MILLWORKER SO SUBMIT THREE (3) MATCHING 3MM PVC EDGE BANDING SAMPLE TO ARCHITECT TO FINALIZE COLORS DURING
- REFER TO ELEVATIONS FOR FINISH TYPE UNLESS OTHERWISE NOTED. COORDINATE FINISHES WITH PROVIDED ON FINISH SCHEDULE & FINISH SPECIFICATIONS.
- 8. FURNISH AND INSTALL PLASTIC LAMINATE FACED FINISHED END PANELS, FILLER PANELS, AND FASCIAS, OF ADJACENT SPECIFIED PLASTIC LAMINATE TYPE TO CLOSE OFF ALL ELEVATIONS.
- 9. THE FOLLOWING SUBMITTALS SHALL BE MADE BY THE MILLWORKER
- 9.1. SHOP DRAWINGS SHOWING LOCATION OF EACH ITEM, DIMENSIONED PLANS AND ELEVATIONS, LARGE-SCALE DETAILS, ATTACHMENT DEVICES, HARDWARE & ACCESSORY CUT SHEETS, AND OTHER COMPONENTS AS REQUIRED SHALL BE SUBMITTED TO
- 10. SAMPLES FOR VERIFICATION PURPOSES OF THE FOLLOWING:
- 10.1. LAMINATE CLAD PANEL PRODUCTS, 8-1/2 INCHES, BY 11 INCHES FOR EACH TYPE, COLOR, PATTERN, AND SURFACE FINISH, WITH SEPARATE SAMPLES OF UNFACED PANEL PRODUCT USED FOR
- 10.2. SOLID SURFACE MATERIALS, 6 INCHES BY 6 INCHES FOR EACH TYPE, COLOR, PATTERN, AND SURFACE FINISH 10.3. CABINET HARDWARE, ONE UNIT OF EACH TYPE AND FINISH.
- 11. CONTRACTOR SHALL TAKE NOTE OF EXISTING AV EQUIPMENT RACKS AND LIGHTING CONTROL PANELS TO BE SALVAGED AND RE-USED IN NEW DESK CONFIGURATION.

HARDWARE & ACCESSORIES

- FULLY CONCEALED EUROPEAN SELF CLOSING HINGE, FOR FLUSH OVERLAY DOORS - 175 DEGREE OPENING BHMA A156.9, B01521
- 2. CATCHES: MAGNETIC CATCHES, BHMA A156.9, B03141
- 3. ADJUSTABLE SHELF STANDARDS AND SUPPORTS: BHMA A156.9, B04102 WITH SHELF BRACKETS, B04112. METAL SHELF STANDARDS RECESSED INTO CABINET SIDES AND ADJUSTABLE METAL SHELF CLIPS.
- DRAWER SLIDES: SIDE-MOUNTED, FULL-EXTENSION, ZINC-PLATED STEEL DRAWER SLIDES WITH STEEL BALL BEARINGS, BHMA A156.9, B05091, AND RATED FOR THE FOLLOWING LOADS: a. BOX DRAWER SLIDES: 100 lbf. b. FILE DRAWER SLIDES: 200 lbf.
- 5. DOOR LOCKS, BHMA A156.11, E07121
- DRAWER LOCKS, BHMA A156.11, B07041
- CABINET DOOR & DRAWER PULLS SHALL BE OF THE FOLLOWING AS INDICATED ON ELEVATIONS, SECTIONS & DETAILS:

SQUARE PULLS: CABINET DRAWERS (U.O.N.): MOCKETT INDUSTRIES

DP175 - FLAT PULL MODEL NO.: DP175A 3-15/16" LONG (MEETS ADA GUIDELINES) LENGTH:

SATIN NICKEL

8. MILLWORK REVEALS AS INDICATED ON ELEVATIONS, SECTIONS &

FRY REGLET MILLWORK REVEAL

ARCHITECT TO SELECT FROM FULL LINE OF MANUF. STANDARD FINISHES DURING

SUBMITTAL REVIEW.

9. GROMMETS FOR CABLE PASSAGE THROUGH COUNTERTOPS: QUANTITY AS INDICATED ON DRAWINGS OR A MINIMUM OF ONE (1) PER EVERY

OPEN WORK AREA GROMMETS:

MOCKETT INDUSTRIES GROMMETS & WIRE MANAGEMENT "THE MAX" SMALL SQUARE GROMMET

> MAX2/A-94 ARCHITECT TO SELECT FROM SILL LINE OF MANUF. STANDARD FINISHES DURING SUBMITTAL REVIEW.

10. UNDER COUNTER WALL BRACKETS SHALL BE SIZED ACCORDINGLY BY THE MILLWORKER PER THE FOLLOWING SPECIFICATIONS. MILLWORKER SHALL SIZE ACCORDINGLY BASED ON SPAN AND WEIGHT OF WORK

ALL BRACKETS SHALL BE:

EH COUNTERTOP SUPPORT BRACKET WITH ROUNDED ENDS EHR-1818 (18" X 18") ARCHITECT TO SELECT FROM SILL LINE OF MANUF. STANDARD FINISHES DURING

SUBMITTAL REVIEW.

1. EXPOSED HARDWARE FINISHES NOT ALREADY SPECIFIED: FOR EXPOSED HARDWARE, PROVIDE FINISH THAT COMPLIES WITH BHMA A156.18 FOR BHMA FINISH NUMBER INDICATED. - SATIN CHROMIUM PLATED: BHMA 652 FOR STEEL BASE - SATIN STAINLESS STEEL: BHMA 630

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Revisions / Issues

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DO NOT SCALE. DRAWING MAY BE PRINTED AT REDUCED SCALE. CONSULT WITH ARCHITECT FOR DIMENSIONS.

Montclair State University

Project:

1 Normal Avenue Montclair, NJ 07043

Admin Reception Desk Renovation at Student Recreation Center MSU Project Number: PR20C014

Drawing Information:

Sheet Name:

Project No: 23.027 Drawn By: SBT Checked By: CHK

Enlarged Floor Plan, Millwork Elevations and Sections

Sheet No:

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